
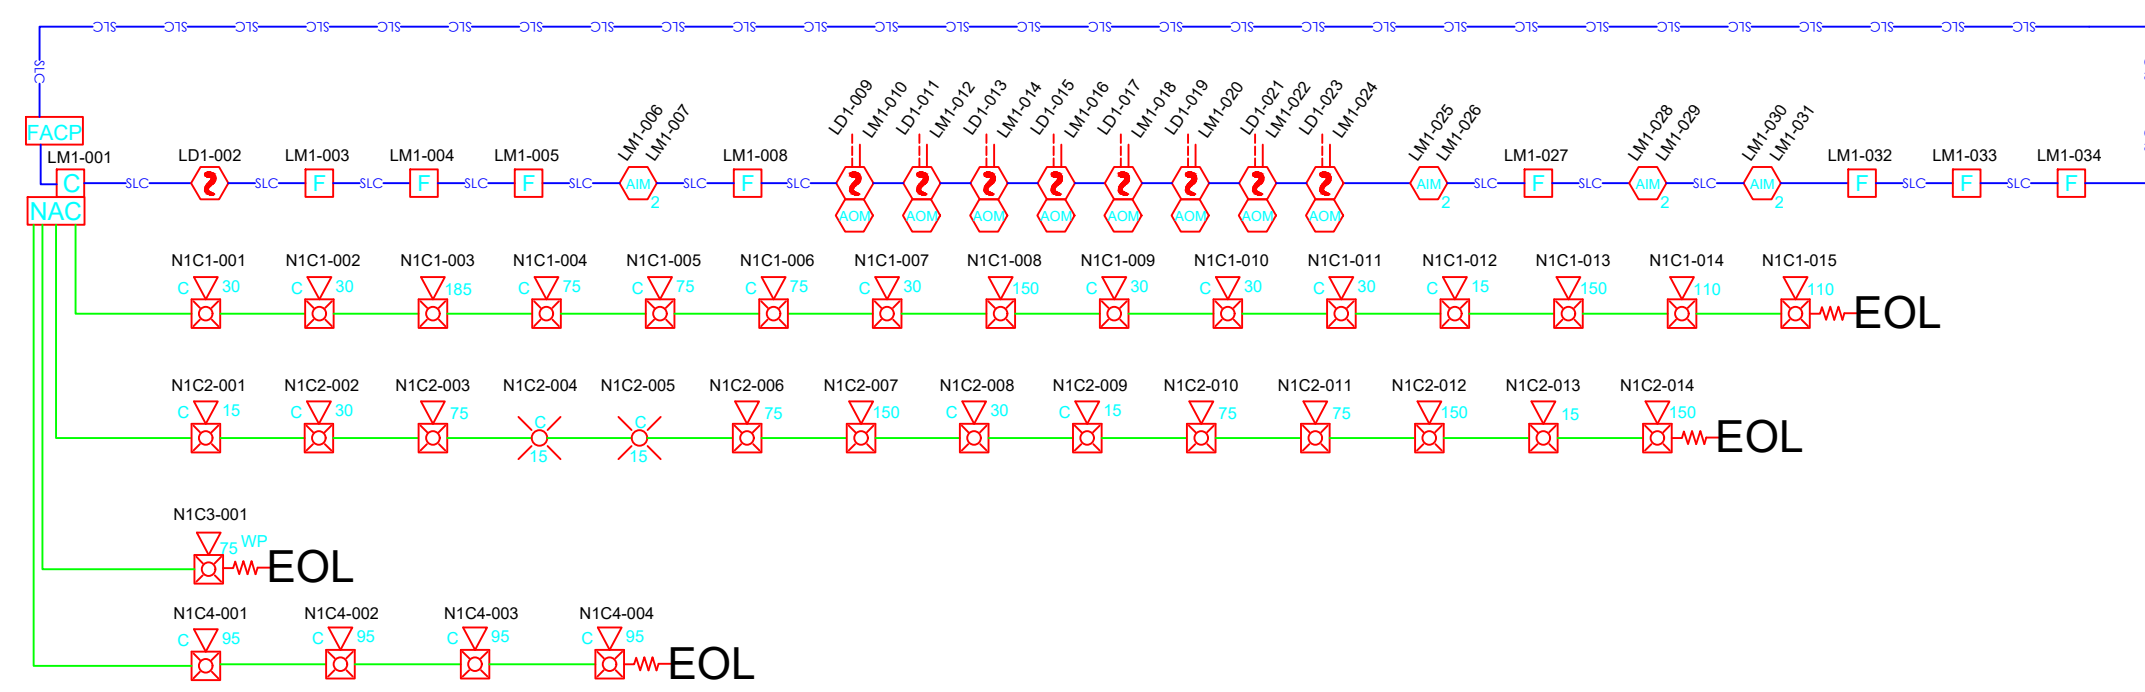


# SITE PLAN

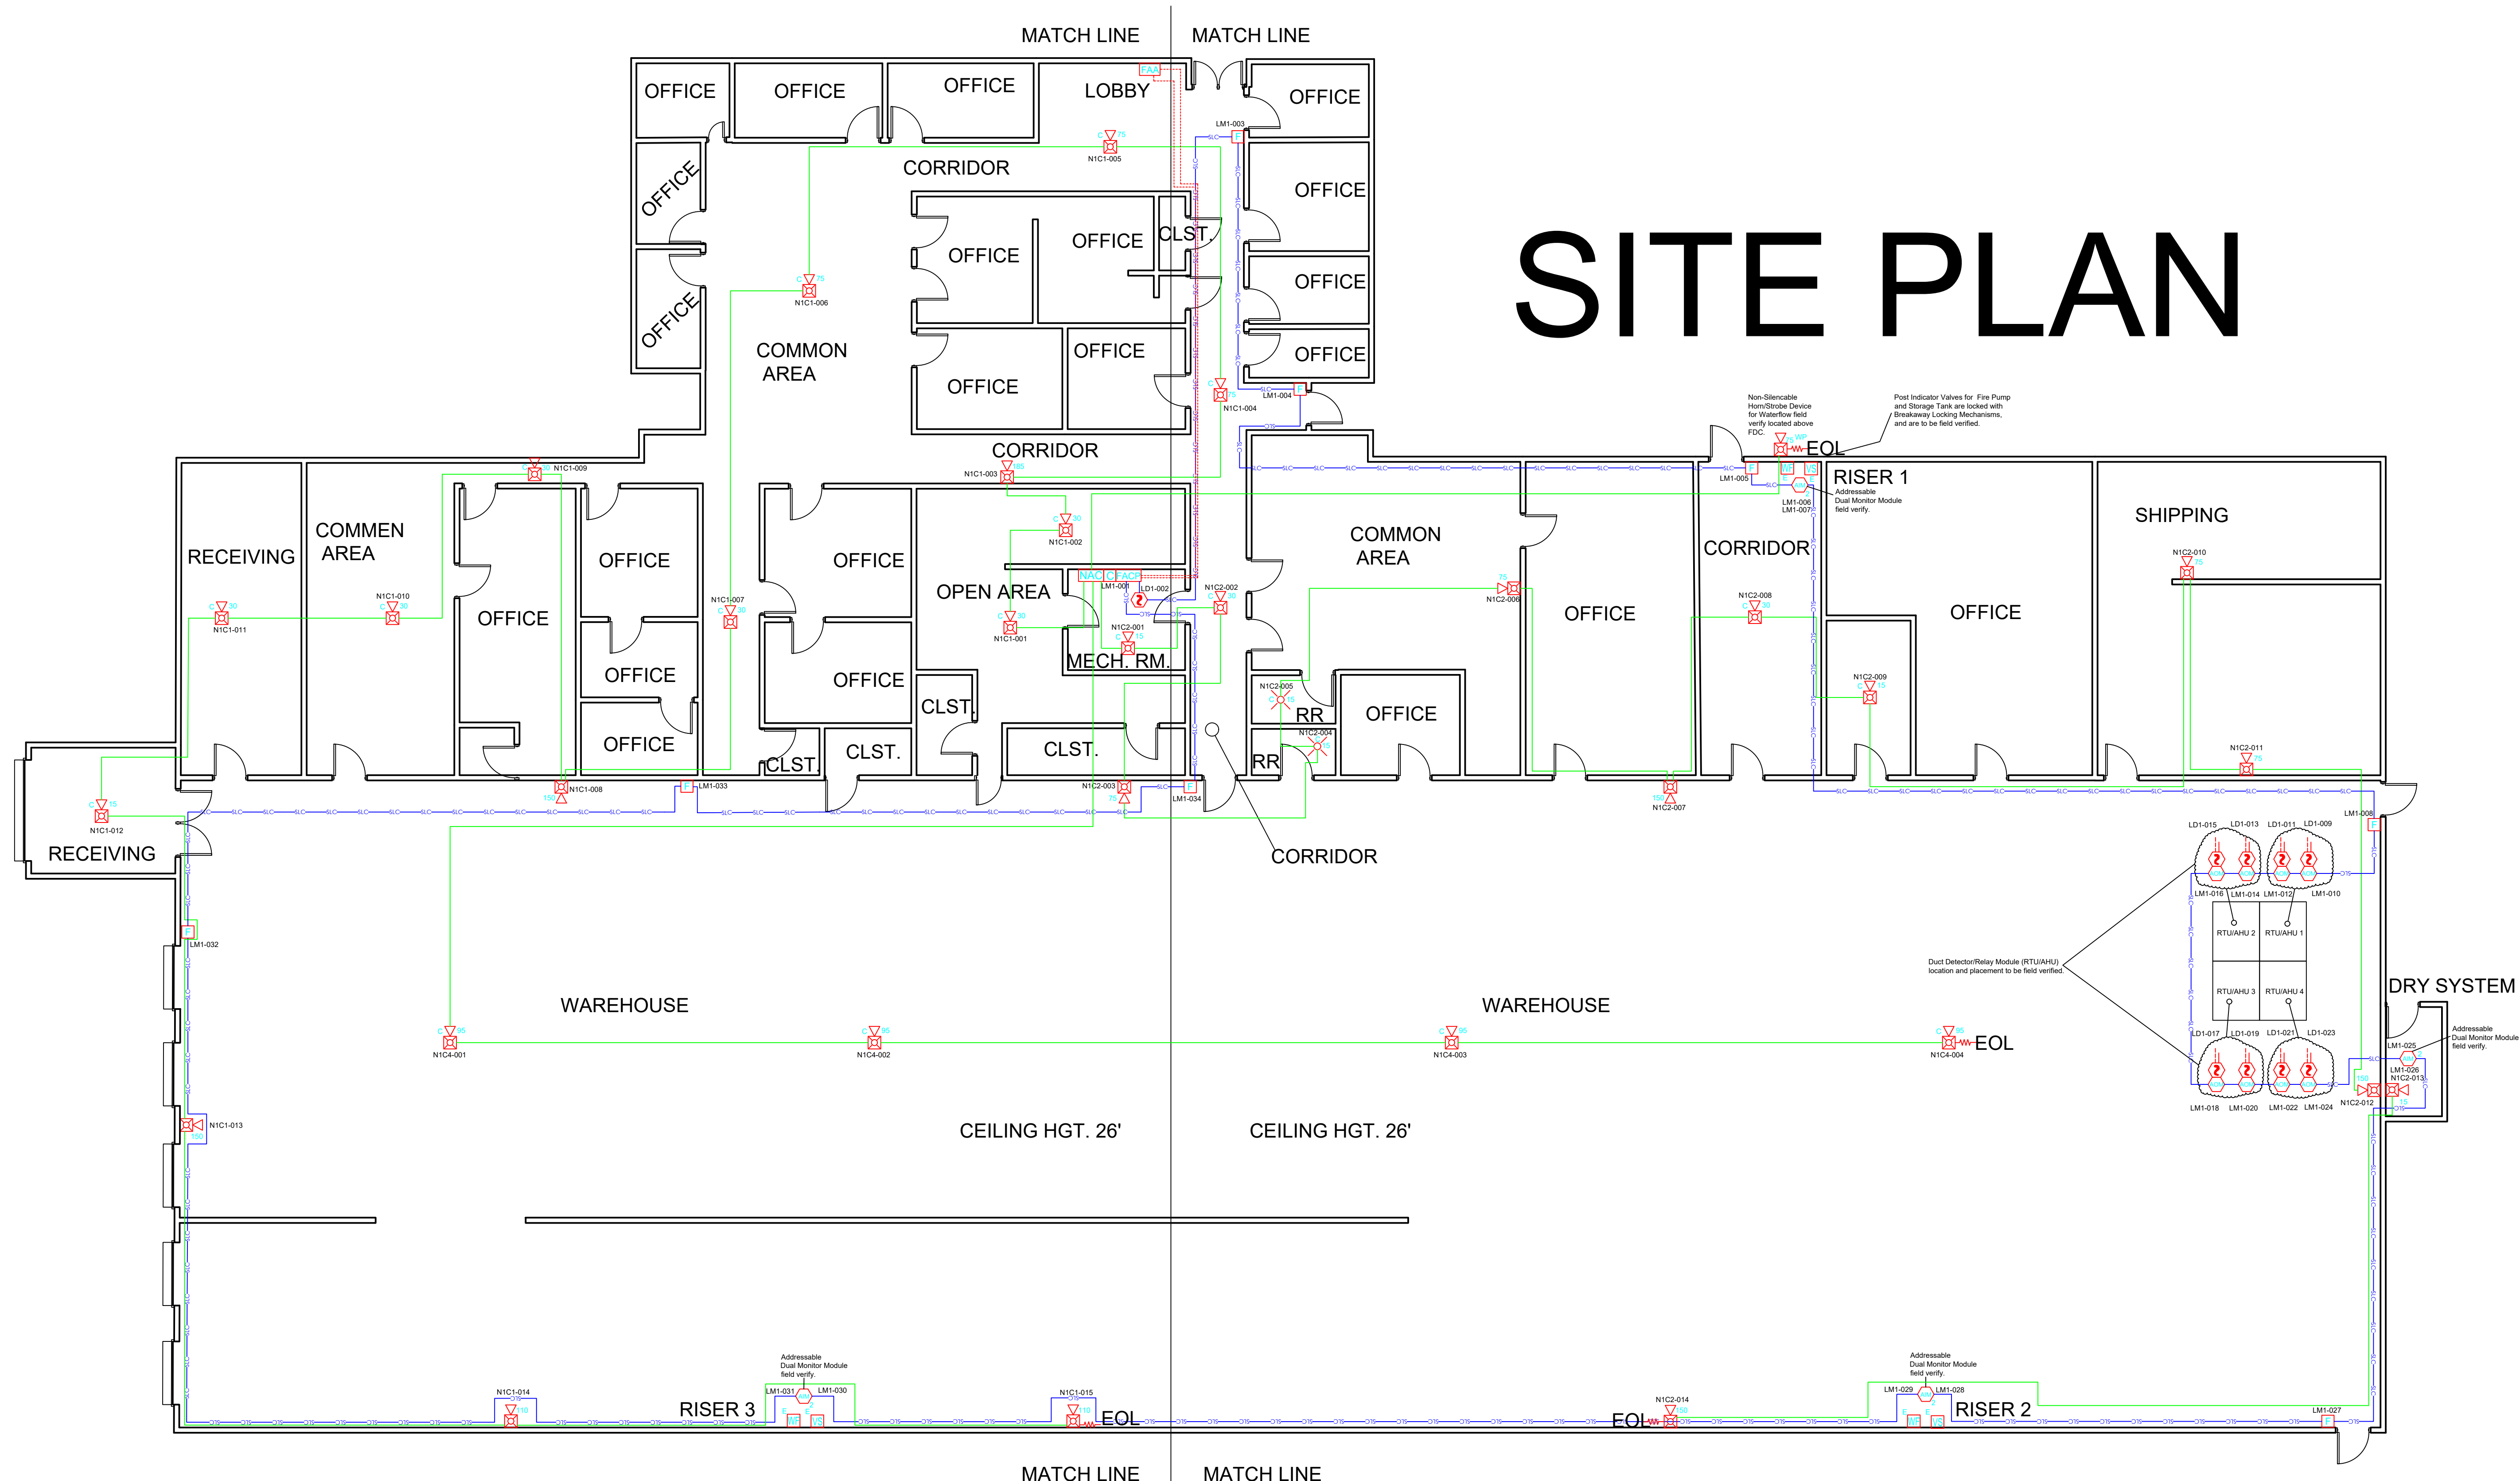

**RISER DIAGRAM**  
SCALE: NTS

**SCOPE:**  
THIS PROJECT IS A NEW FIRE ALARM ADDITION TO AN EXISTING FACILITY AT 1001 FISHER RD. LONGVIEW, TEXAS. A NOTIFIER 50X FIRE ALARM SYSTEM WILL BE INSTALLED ALONG WITH A NOTIFIER PSE 10 CIRCUIT BOOSTER. NEW SYSTEM SENSOR NOTIFICATION DEVICES SHALL ALSO BE INSTALLED. ALL EQUIPMENT WILL BE INSTALLED IN ACCORDANCE WITH LOCAL AND STATE CODES AND STANDARDS.

- GENERAL NOTES:**
1. CEILING HEIGHT: 9' UNLESS OTHERWISE NOTED
  2. TYPE OF CONSTRUCTION: NEW
  3. WIRING METHOD: EXPOSED PLENUM RATED, UNLESS OTHERWISE NOTED
  4. SLC, CLASS A, TO MAINTAIN 6' SEPARATION
  5. NOTIFICATION CIRCUITS, CLASS B

**DRAWING INDEX:**  
FA1 SITE PLAN KEY AND RISER INFORMATION  
FA1-1 NORTH AREA  
FA1-2 SOUTH AREA

- CAUSE AND EFFECT:**
1. SMOKE DETECTOR ACTIVATES GENERAL ALARM.
  2. PULL STATIONS ACTIVATES GENERAL ALARM.
  3. DUCT DETECTORS L1D1-009, L1D1-011, ACTIVATE RELAYS L1M1-010, L1M1-012 FOR RTU/AHU 1 SHUTDOWN, L1D1-013 AND L1D1-015 ACTIVATE RELAYS L1M1-014, L1M1-016 FOR RTU/AHU 2 SHUTDOWN, L1D1-017, AND L1D1-019 ACTIVATE L1M1-018 AND L1M1-020 FOR RTU/AHU 3 SHUTDOWN, L1D1-021, AND L1D1-023 ACTIVATE RELAYS L1M1-022, AND L1M1-024 FOR AHU-RTU 4 SHUTDOWN.
  4. WATER FLOW MONITOR ACTIVATES GENERAL ALARM.
  5. VALVE TAMPER MONITOR ACTIVATES SUPERVISORY.
  6. ALL ADDRESSES TO BE FIELD VERIFIED AND ADDED TO AS BUILT
  7. NOTIFICATION DEVICES ACTIVATE ON GENERAL ALARM
  8. ALARM, TROUBLE, AND SUPERVISOR REPORT TO MAIN OFFICE AREA.

**BUILDING INFORMATION:**  
AHJ: LONGVIEW FIRE MARSHAL  
SPRINKLERED: FULLY  
IFC 2012,  
GROUP H-5  
CONSTRUCTION TYPE: EXISTING  
BUILDING  
FIRE ALARM UPDATE

**Old Rexam Plant**  
1001 Fisher Rd.  
Longview, Texas 75604

**Firetrol Protection Systems**  
2134-C Anthony Drive  
Tyler, Texas 75701

CONTRACT NO. 41-100590  
DRAWING TITLE: SITE PLAN KEY

ISSUE NO.	MARK	DATE	BY	DESCRIPTION

DRAWN BY: AH  
CHECKED BY: DH  
ISSUE DATE: 05-25-22  
JOB #: 41-100590  
PROJECT #:

SYSTEM: FIRE ALARM SYSTEM  
SHEET:

FOR SUBMITTAL  RECORD DRAWINGS

I have reviewed these plans and certify that they comply with the applicable codes and standards.

Or

certify they were copied from sealed engineering plans and any violations of the applicable codes or standards are specifically noted on these plans.

FIRETROL PROTECTION SYSTEMS  
2134-C ANTHONY DRIVE  
TYLER, TEXAS 75701  
STATE LICENSE NO. ACR-1751168  
PHONE (936) 526-0000  
APR 06/11  
APR License Signature - License #  
Donald Hroch 05-23-22  
APR Printed Name - Date





